# STORMWATER MANAGEMENT PLAN

# 20 QUIGG STREET NORTH LAKEMBA



BE (Civil), MIEAust, CPEng No. 449924

#### SHEET INDEX:

SHEET No.	TITLE	AMMENDMENT No.
1	INDEX SHEET	0
2	STORMWATER DETAIL PLAN	0
3	ROOF PLAN	0
4	HYDRAULIC GRADE LINE ANALYSIS	0
5	RAINWATER TANK DETAILS	0
6	EROSION AND SEDIMENT CONTROL PLAN	0

# PROPOSED STORMWATER PIPE - GRAVITY PROPOSED V-DR PROPOSED STORMWATER PIPE - CHARGED PROPOSED RISING MAIN (PRESSURE PIPE) PROPOSED SUBSOIL DRAIN PROPOSED BUILDING PROPOSED BASEMENT CHANNEL RAINHEAD SU SUMP OVERFLOW IL 4.65 PIT INVERT LEVEL GRATED DRAIN + 48.34 EXISTING SURFACE LEVEL + 30.99 PROPOSED SURFACE LEVEL

FS-2 FLOW SPREADER AND DOWNPIPE TYPE 2

PROPOSED SEALED WATER TIGHT PIT

PROPOSED GRATED PIT

**LEGEND** 

**FLOWPATH** 

FLOOR WASTE

DP-1 DOWNPIPE - TYPE 1

BASIX ROOF AREA DRAINING TO RAINWATER TANK

AREA BYPASSING ON-SITE DETENTION TANK

SEALED INSPECTION OPENING

#### NOTES:

- 1. ALL PROPOSED PITS TO BE 450 x 450 CAST IN-SITU OR PRECAST PITS UNLESS SHOWN OTHERWISE.
- ALL CHARGED LINE PIPES TO BE 100Ø uPVC SEWER CLASS UNLESS SHOWN OTHERWISE
- 3. ALL DOWNPIPES TO BE 90Ø uPVC OR 100 x 50 UNLESS OTHERWISE SHOWN
- 4. ALL NON-PRESSURE STORMWATER PIPES TO BE 100Ø uPVC UNLESS SHOWN OTHERWISE
- 5. ALL GRATED DRAINS TO BE MINIMUM 150 WIDE GALVANIZED HEAVY DUTY GRATES.6. ALL NON-TRAFFICABLE PITS TO BE LIGHT DUTY. PITS
- IN TRAFFICABLE AREAS TO BE HEAVY DUTY.

  7. ALL WORK SHALL BE CARRIED OUT IN ACCORDANCE
- WITH COUNCILS SPECIFICATIONS.

  8. ALL PITS GREATER THAN 1.2m DEPTH SHALL
- DIMENSIONS OF 600 x 600.

  9. ALL PITS ARE TO BE BENCHED TO ALLOW SMOOTH FLOW OF WATER THROUGH PITS

INCLUDE STEP IRONS AND HAVE MINIMUM CLEAR

- ALL DOWNPIPES SHALL CONFORM TO AS/NZS 1866
   FOR ALUMINIUM PIPES AND AS 1254, AS/NZS 1260, AS
   1273, AS/NZS 1477, AS/NZS 2179.2 AND AS 2032 FOR
   uPVC PIPES.
- 11. ALL BOX GUTTERS SHALL COMPLY WITH AS/NZS
- 12. ALL BOX GUTTERS SHALL BE CONSTRUCTED WITH A MINIMUM 1:200 GRADE TO SUMP/DOWNPIPES
- 13. ALL DRAINAGE WORKS SHALL BE IN ACCORDANCE WITH AS 3500.3.2

DOWNPIPE TYPE	DOWNPIPE SIZES						
DOWNFIPE I TPE	ROUND	RECTANGULAR					
1	90Ø	100 X 75					
2	100Ø	100 X 75					
3	125Ø	100 X 100					
4	150Ø	150 X 150					

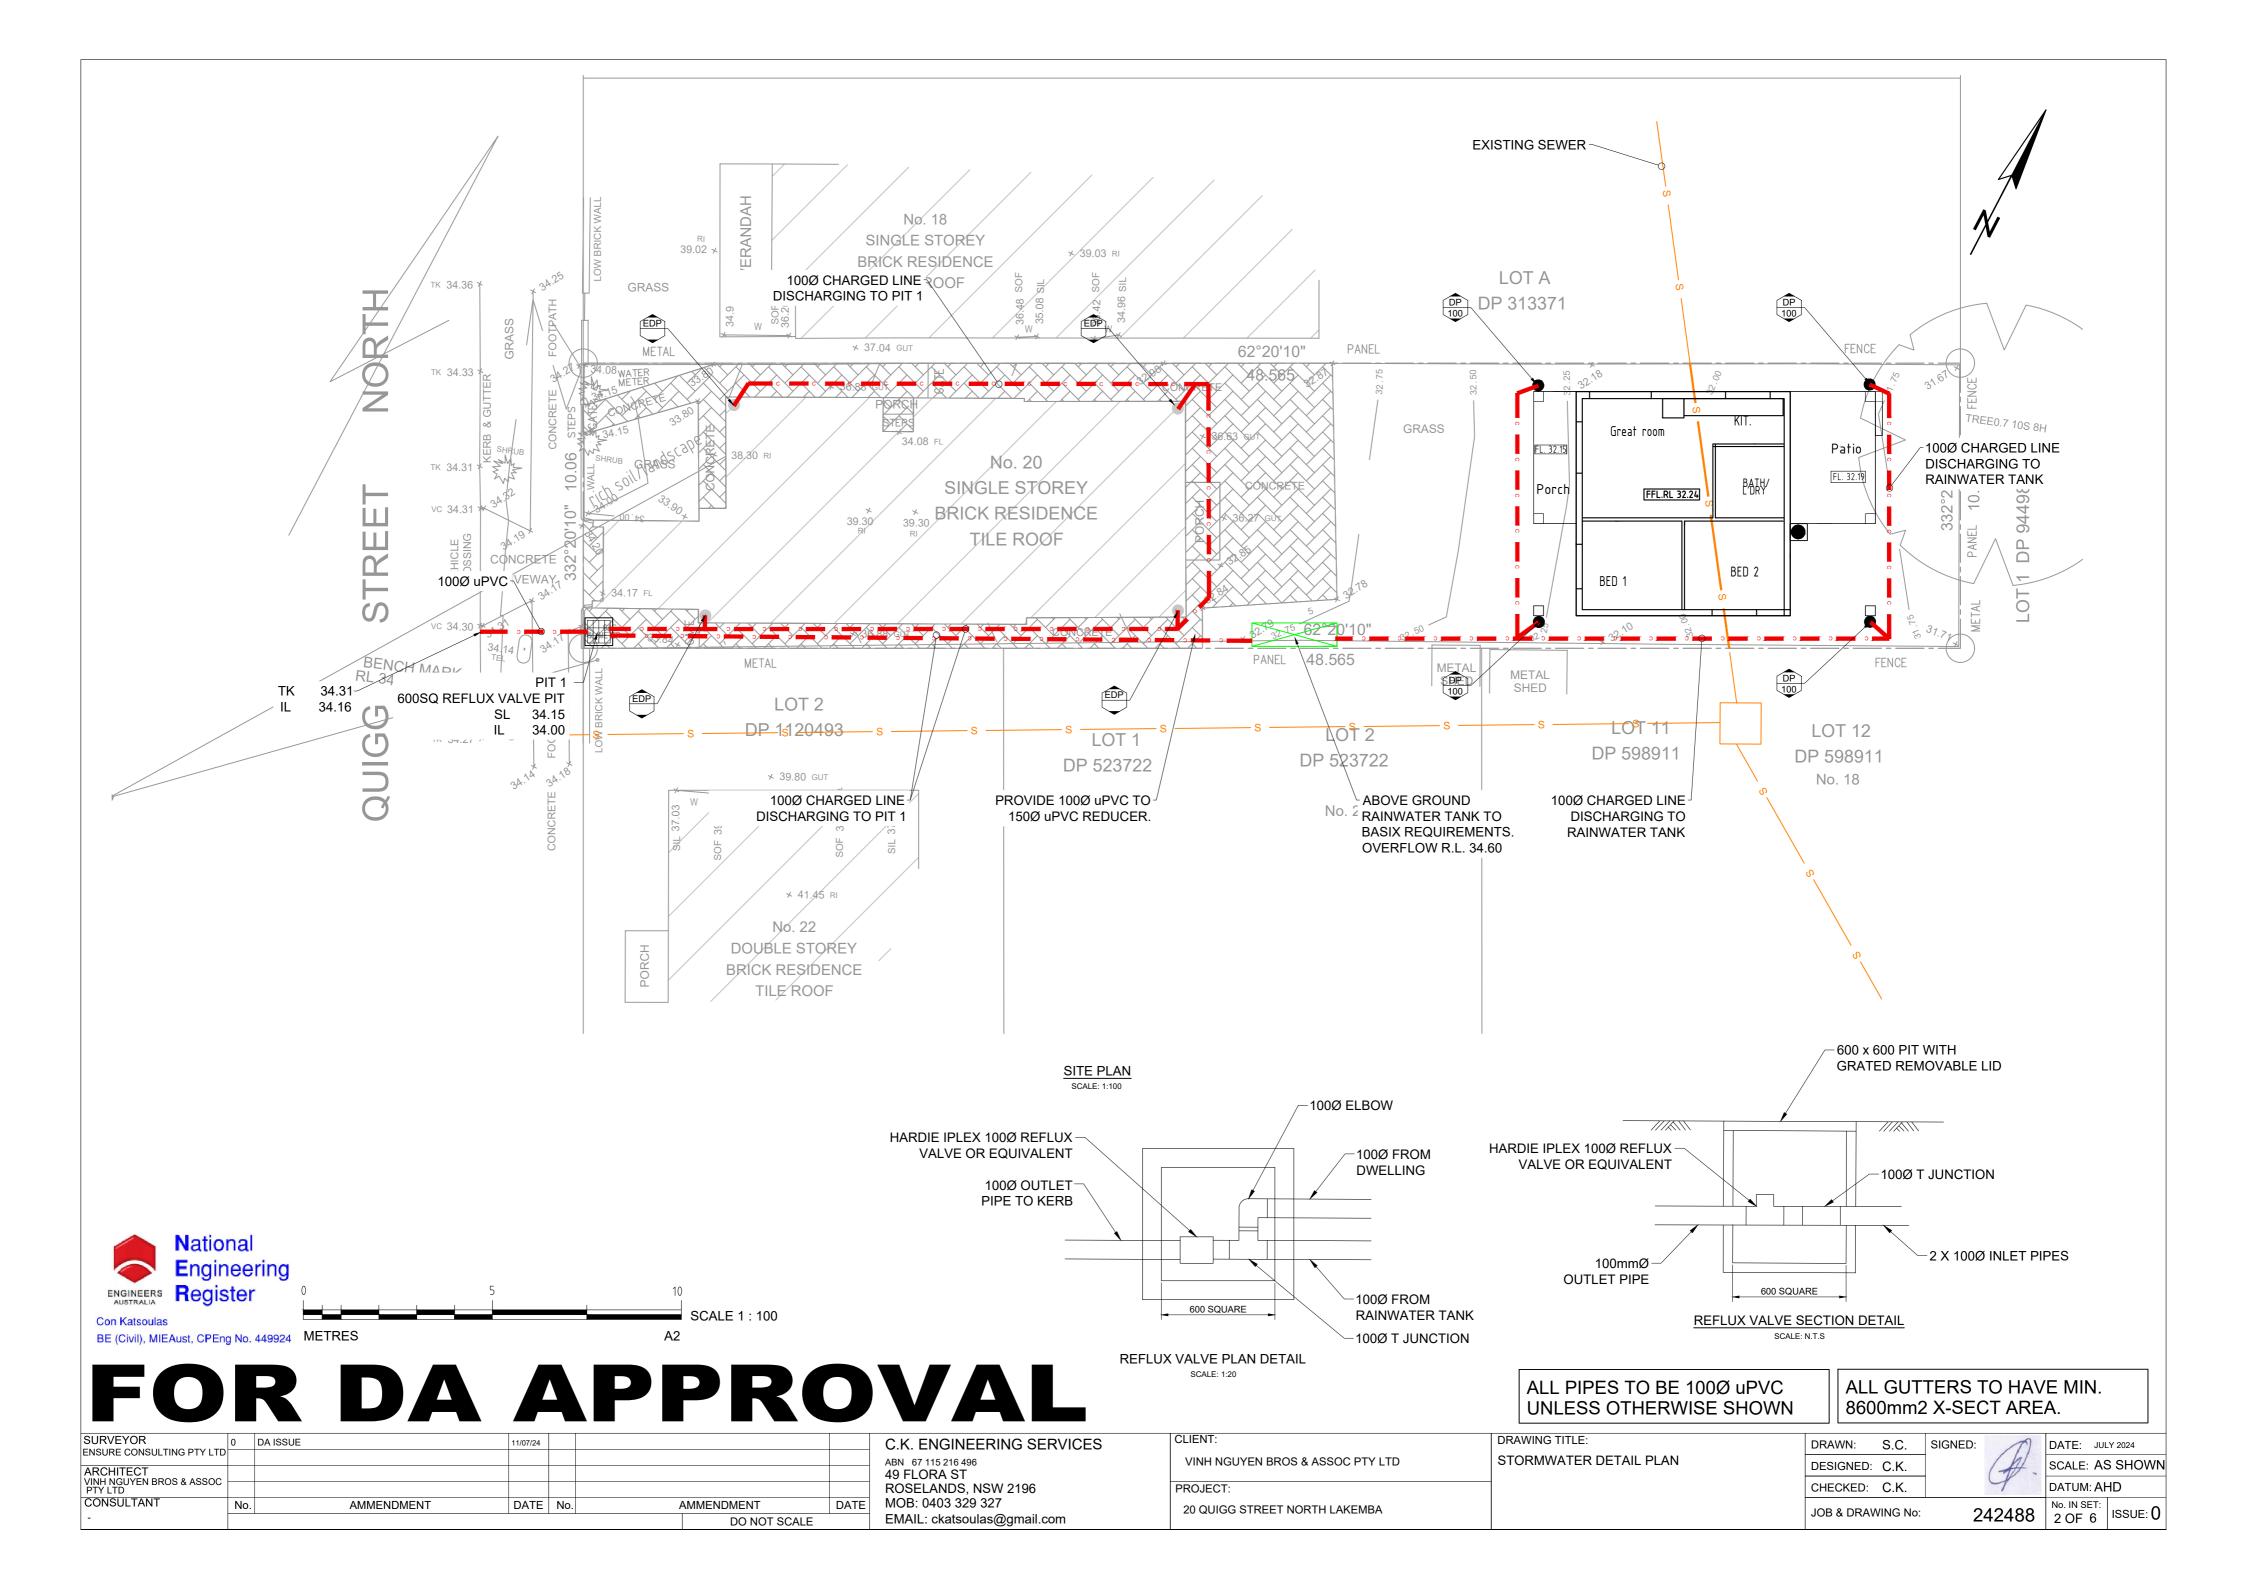
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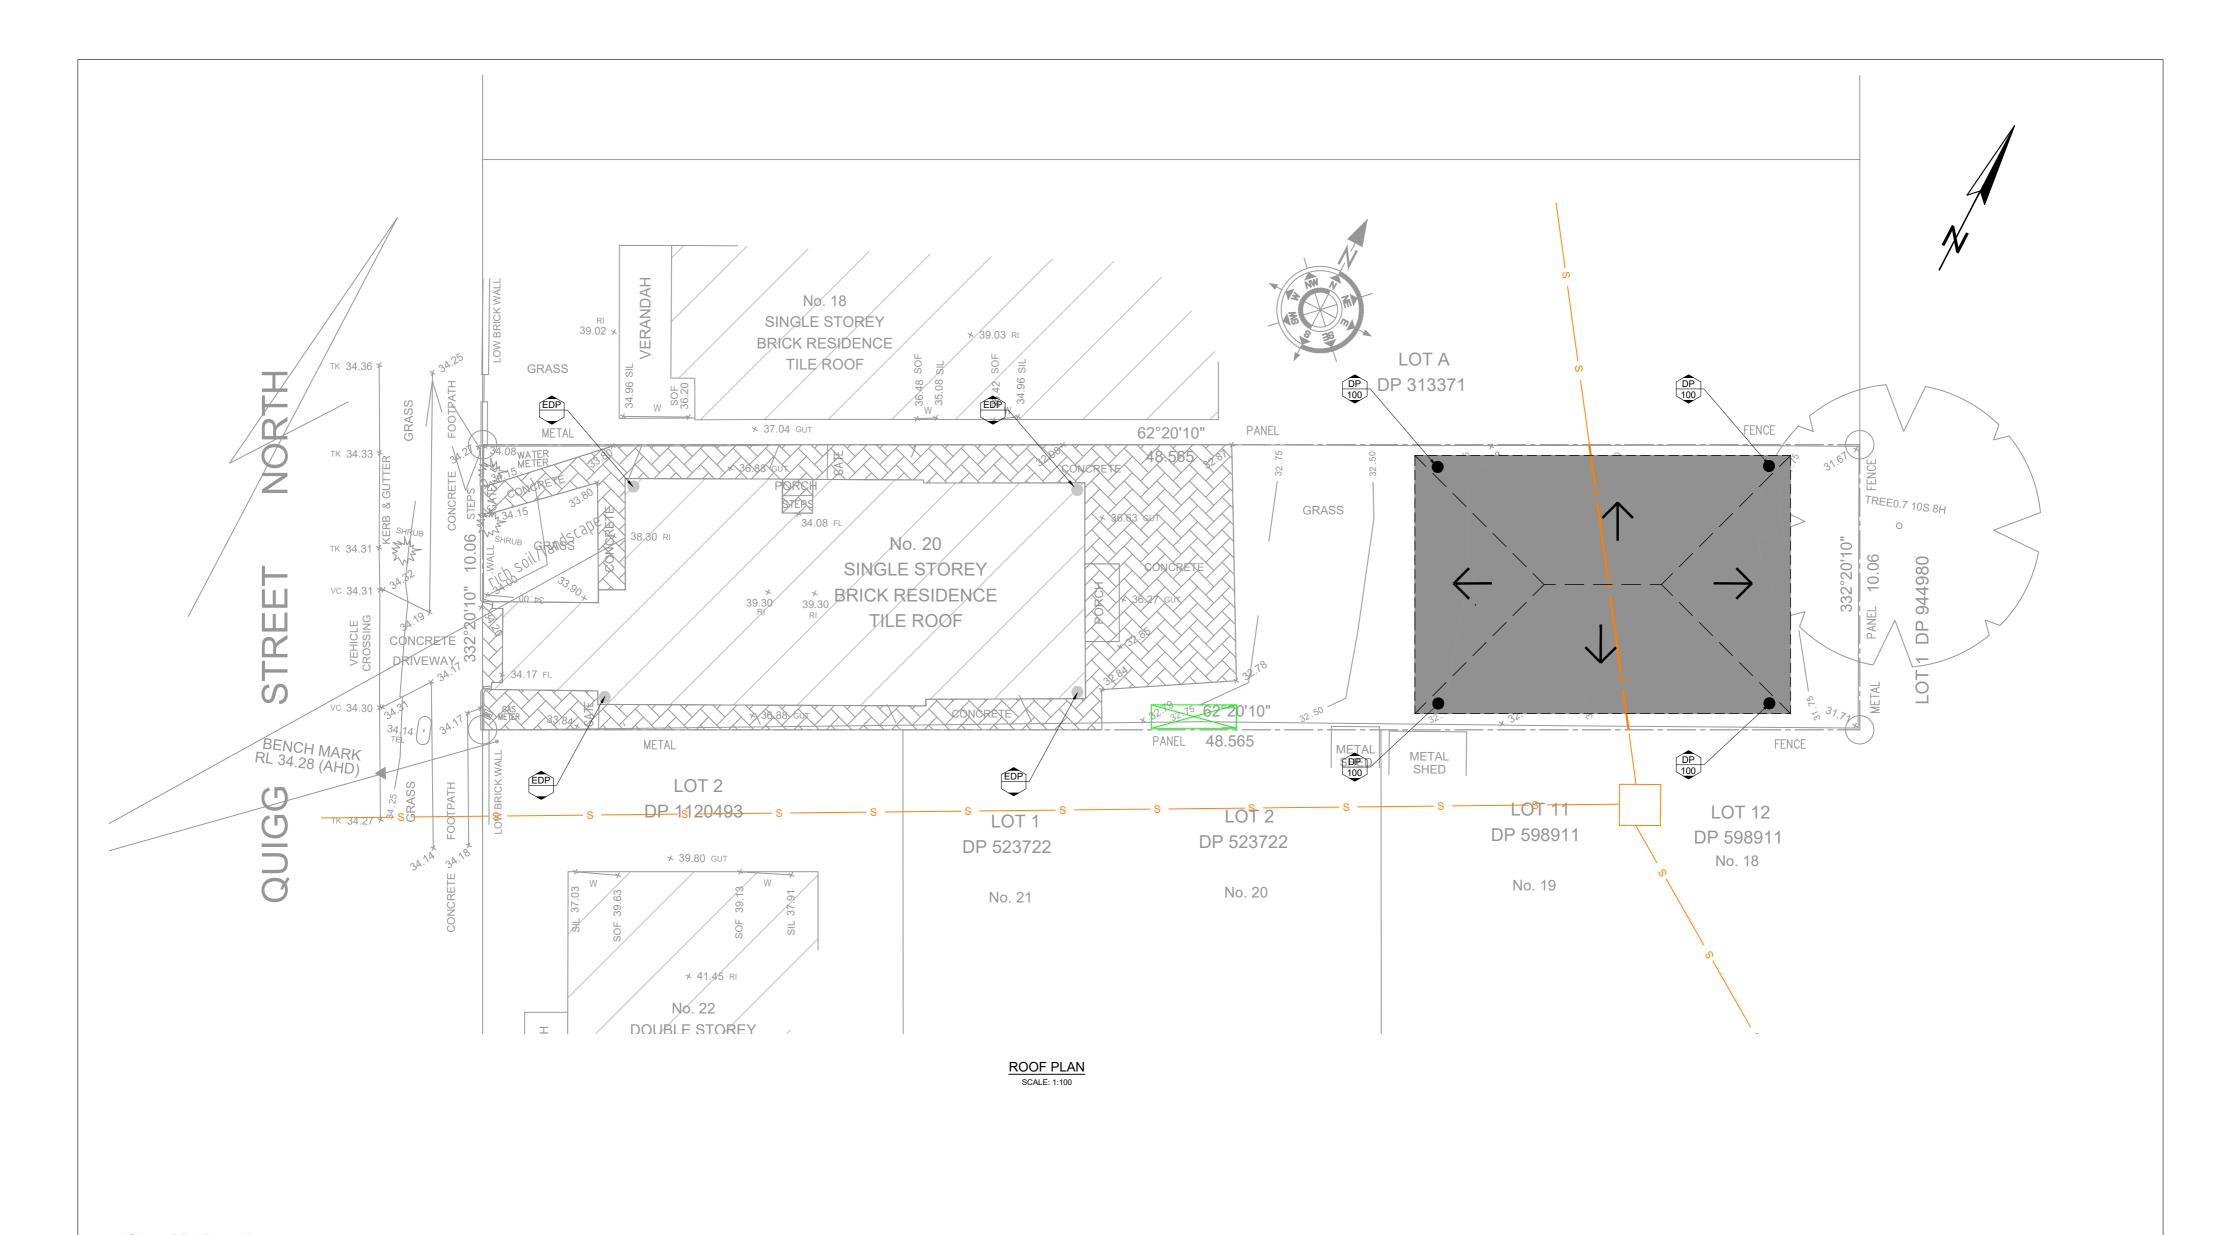
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ENSURE CONSULTING PTY LTD								ABN 67 115 216 496
ARCHITECT								49 FLORA ST
VINH NGUYEN BROS & ASSOC PTY LTD								ROSELANDS, NSW 2196
CONSULTANT	No.	. AMMENDMENT	DATE	No.	,	AMMENDMENT	DATE	MOB: 0403 329 327
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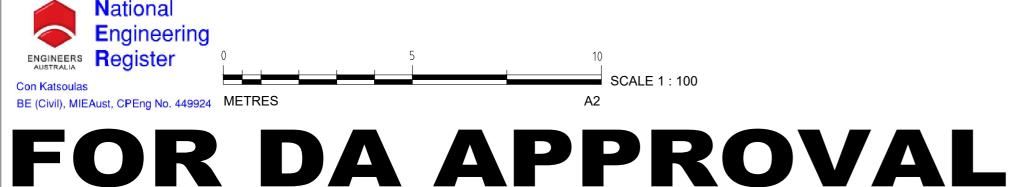
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VINH NGUYEN BROS & ASSOC PTY LTD	INDEX
PROJECT:	
20 QUIGG STREET NORTH LAKEMBA	

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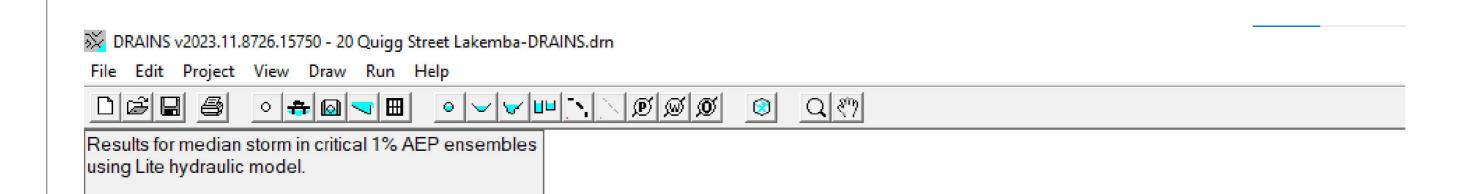
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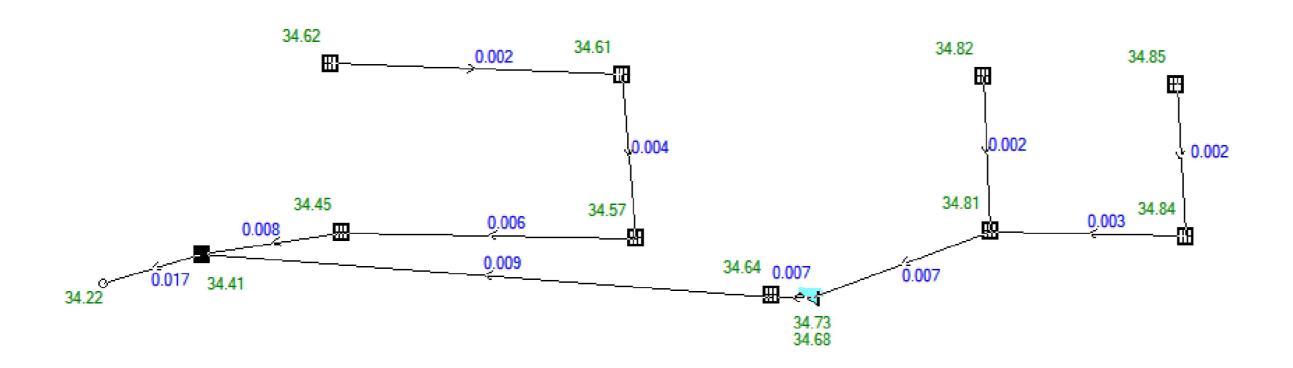






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ENSURE CONSULTING PTY LTD							ABN 67 115 216 496	VINH NGUYEN BROS & ASSOC PTY LTD	ROOF PLAN	DESIGNED: C.K	(h)	SCALE: A	S SHOWN
ARCHITECT VINH NGUYEN BROS & ASSOC							49 FLORA ST ROSELANDS, NSW 2196	PROJECT:		CHECKED: C.K	<del>-</del>	DATUM: A	HD
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#### 5% AEP DRAINS RESULTS

#### HYDRAULIC GRADE LINE ANALYSIS

HYDRAULIC GRADE LINE CALCULATIONS DESIGN ARI = 20 YR ARI

FLOW PER DOWN PIPE; EXISTING DWELLING = 2 L/s GRANNY FLAT = 1.7 L/s

GUTTER LEVEL
EXISTING DWELLING = 36.6 m AHD
GRANNY FLAT = 34.985m AHD



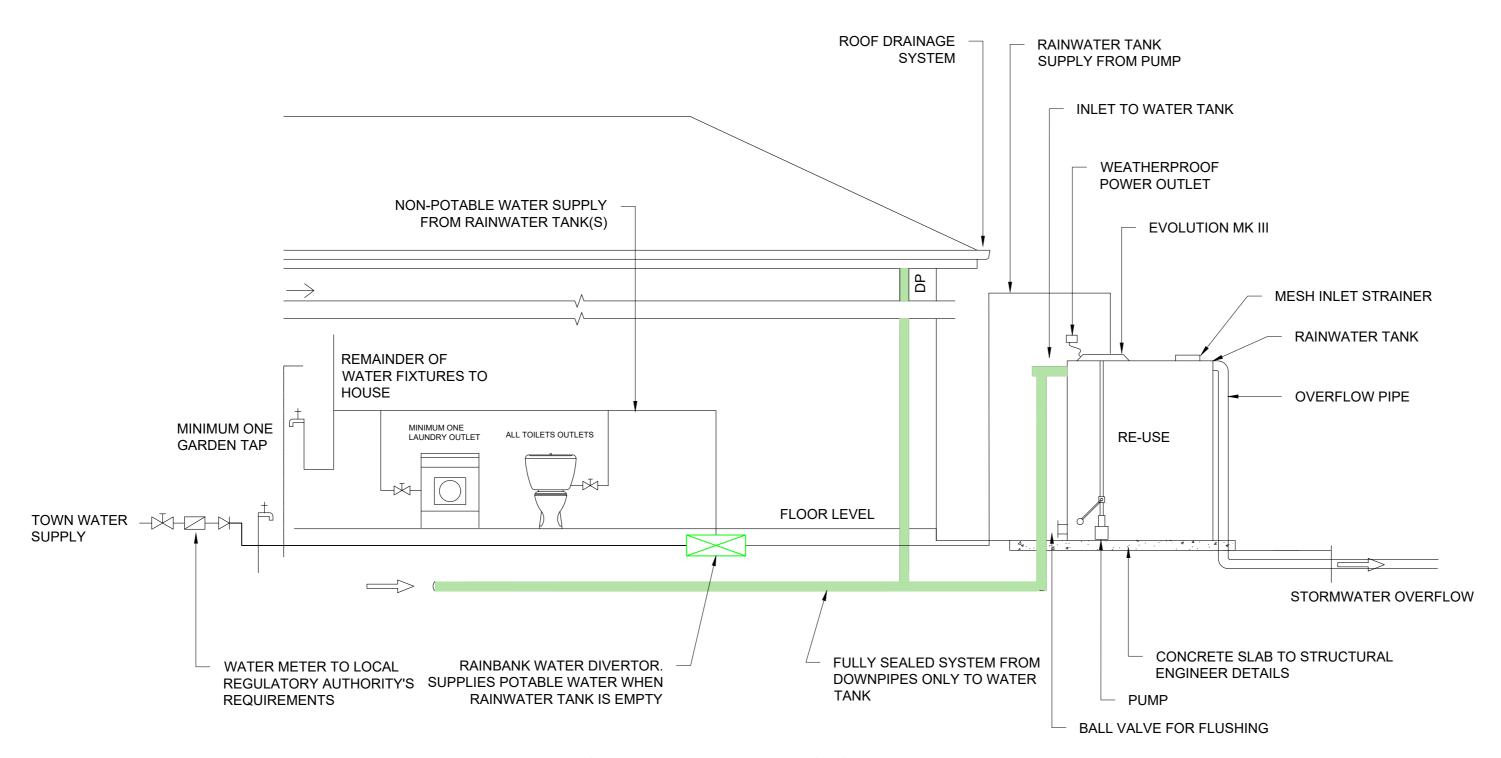
BE (Civil), MIEAust, CPEng No. 449924

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	ARCHITECT								49 FLORA ST	
	VINH NGUYEN BROS & ASSOC PTY LTD								ROSELANDS, NSW 2196	PROJECT:
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CLIENT:	DRAWING TITLE:
VINH NGUYEN BROS & ASSOC PTY LTD	HYDRAULIC GRADE LINE ANALYSIS
PROJECT:	
20 QUIGG STREET NORTH LAKEMBA	

DRAWN:	S.C.	SIGNED:	M	DATE: JU	LY 2024
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#### TYPICAL RAINWATER TANK SYSTEM

SCALE: N.T.S

#### RAINWATER TANK NOTES

**RAINWATER TANKS ARE TO BE:** 

ERECTED ON A SELF-SUPPORTING BASE IN THE APPROVED LOCATION ON THE PROPERTY IN ACCORDANCE WITH THE STAMPED-APPROVED SITE PLANS FOR THE DEVELOPMENT,

STRUCTURALLY SOUND AND CONSTRUCTED IN ACCORDANCE WITH AS/NZS 3500 1.2- 1998: NATIONAL PLUMBING AND DRAINAGE - WATER SUPPLY - ACCEPTABLE SOLUTIONS,

FULLY ENCLOSED AND ALL OPENINGS SEALED TO PREVENT ACCESS BY MOSQUITOES,

FITTED WITH A FIRST FLUSH DEVICE,

FITTED WITH A TRICKLE SYSTEM TO TOP UP FROM MAINS WATER, PROVIDED WITH AN AIR GAP, AND

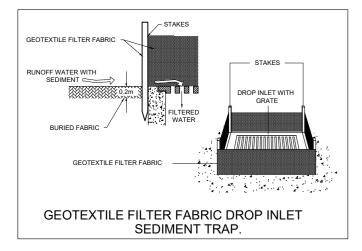
INSTALLED BY A LICENSED PLUMBER IN ACCORDANCE WITH SYDNEY WATER'S "PLUMBING REQUIREMENTS INFORMATION FOR RAINWATER TANK SUPPLIERS AND PLUMBERS APRIL 2003" AND THE NSW CODE OF PRACTICE: PLUMBING AND DRAINAGE.

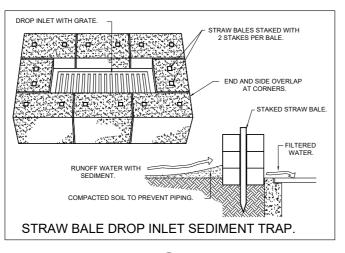
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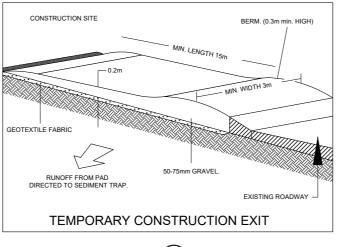
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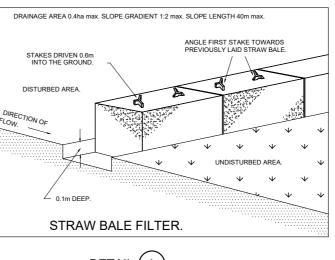
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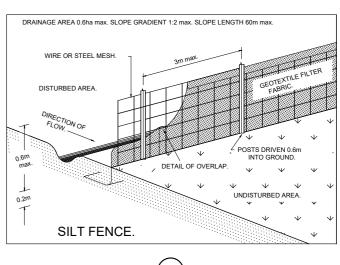
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ARCHITECT							ABN 67 115 216 496	VINH NGUYEN BROS & ASSOC PTY LTD	RAINWATER TANK DETAILS	DESIGNED:	C.K.	(h)	SCALE: AS SHOWN
VINH NGUYEN BROS & ASSOC							49 FLORA ST ROSELANDS, NSW 2196	PROJECT:		CHECKED:	C.K.	F	DATUM: AHD
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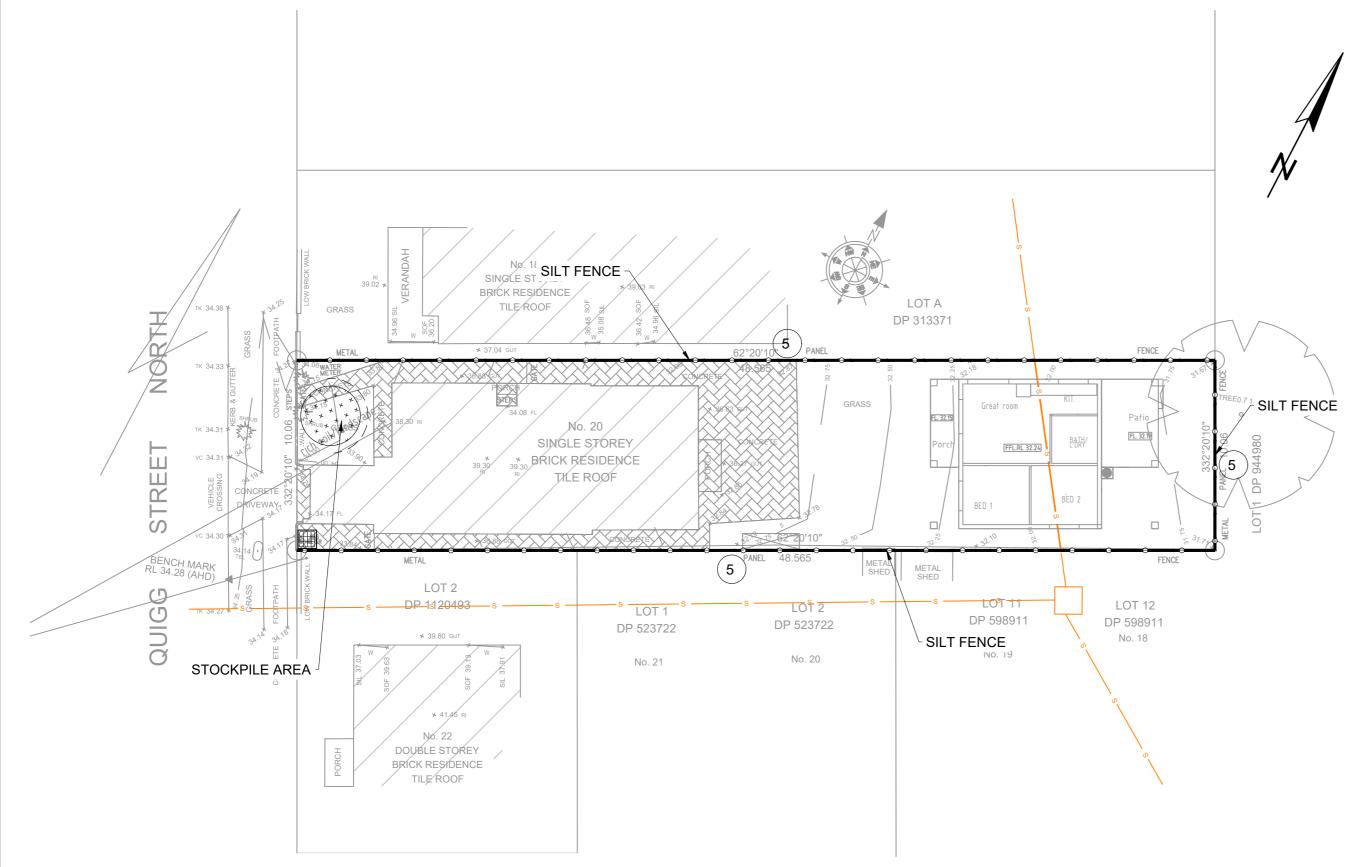
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 $\underline{\mathsf{DETAIL}}(2)$ 

DETAIL (3)

DETAIL (4)

DETAIL (5)



#### **EROSION CONTROL NOTES:**

- ALL WORK SHALL BE CARRIED OUT IN ACCORDANCE WITH COUNCIL'S STANDARD SPECIFICATIONS AND TO THE SATISFACTION OF COUNCIL'S ENGINEER.
- 2. EROSION AND SEDIMENTATION CONTROLS SHALL BE CONSTRUCTED AS SHOWN ON SHEET 2 AND 3 OF THIS PLAN AND/OR WHERE DIRECTED BY COUNCIL'S ENGINEER.
- SEDIMENTATION AND EROSION CONTROL DEVICES SHALL BE IMPLEMENTED PRIOR TO OR IN CONJUNCTION WITH THE FIRST PHASE OF EARTHWORKS AND SHALL BE REMOVED ONLY WHEN THE AREAS ABOVE IT HAVE BEEN STABILISED. EACH SEDIMENTATION AND EROSION CONTROL DEVICE SHALL BE INSPECTED AFTER EACH STORM FOR STRUCTURAL DAMAGE OR CLOGGING BY SILT AND OTHER DEBRIS AND PROMPTLY DESILTED, REPAIRED OR REPLACED IF REQUIRED.
- TOPSOIL STOCKPILES SHALL BE LOCATED OUTSIDE HAZARD AREAS SUCH AS DRAINAGE DEPRESSIONS.
- ALL AREAS NOT SUBJECT TO CONSTRUCTION WORKS SHALL BE RETAINED FREE FROM DISTURBANCE OR DAMAGE FOR THE DURATION OF THE WORKS.
- TREES TO BE RETAINED SHALL BE PROTECTED DURING SITE WORKS AND CONSTRUCTION BY THE ERECTION OF SOLID BARRICADES AT THE DRIP LINE OR AS SPECIFIED BY COUNCIL'S ENGINEER.
- THE DEVELOPER OR CONTRACTOR WILL TAKE ALL MEASURES TO PREVENT DAMAGE TO TREES AND ROOT SYSTEMS DURING SITE WORKS AND CONSTRUCTION ACTIVITIES INCLUDING THE PROVISION OF WATER, SEWERAGE AND STORMWATER DRAINAGE SERVICES. IN PARTICULAR, WORKS, ERECTION OF STRUCTURES, EXCAVATION OR CHANGES TO SOIL LEVELS WITHIN 4 METRES OF THE TRUNKS OF TREES TO BE RETAINED ARE NOT PERMITTED UNLESS PART OF THE DEVELOPMENT AS APPROVED, AND THE STORAGE OF SPOIL, BUILDING MATERIALS, SOILS OR THE DRIVING OR PARKING OF ANY VEHICLE OR MACHINERY WITHIN 4 METRES OF THE TRUNK OF A TREE TO BE RETAINED, IS NOT PERMITTED.
- WETTING OF THE SITE SHOULD BE CARRIED OUT AS OFTEN AS NECESSARY AS A FORM OF DUST CONTROL.
- SILT FENCES TO BE CONSTRUCTED WHERE EVER NATURAL SURFACE SLOPES AWAY FROM DISTURBED AREAS OR WHERE DIRECTED BY THE ENGINEER.

DRAWN:

DESIGNED: C.K.

CHECKED: C.K.

JOB & DRAWING No:

**EROSION AND SEDIMENT CONTROL PLAN** SCALE: 1:150

## FOR DA APPROVAL

ARCHITECT VINH NGUYEN BROS & ASSOC PTY LTD CONSULTANT AMMENDMENT DATE No. **AMMENDMENT** DO NOT SCALE

ABN 67 115 216 496 49 FLORA ST ROSELANDS, NSW 2196 MOB: 0403 329 327 EMAIL: ckatsoulas@gmail.com CLIENT: DRAWING TITLE: **EROSION AND SEDIMENT CONTROL PLAN** VINH NGUYEN BROS & ASSOC PTY LTD PROJECT: 20 QUIGG STREET NORTH LAKEMBA

**N**ational Engineering

Con Katsoulas BE (Civil), MIEAust, CPEng No. 449924

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